CONTRACTOR TO VERIFY **MASONRY OPENINGS**

- THE INFORMATION PROVIDED IN THE DOOR AND WINDOW SCHEDULES NEEDS TO BE VERIFIED BY THE CONTRACTOR PRIOR TO COMMENCING CONSTRUCTION.
- THE MANUFACTURER SPECIFIED, IF ANY, (AND ANY MODEL NUMBERS, IF PROVIDED) ARE INTENDED ONLY AS A GENERAL GUIDELINE TO ESTABLISH A DESIGN STANDARD.
- THE DIMENSIONS SHOWN ON THE FLOOR PLANS HAVE BEEN ROUNDED-OFF ONLY FOR THE PURPOSE OF ESTABLISHING THE GENERAL LOCATION OF OPENINGS ON THE ARCHITECTURAL AND STRUCTURAL DRAWINGS.
- THE DIMENSIONS SHOWN ON THE SCHEDULES FOR THE WINDOW AND DOOR ASSEMBLIES, AND THEIR RESPECTIVE MASONRY OPENINGS, ARE NOT EXACT. THEY ARE INTENDED ONLY TO CALL THE CONTRACTOR'S ATTENTION TO THE VARIATIONS IN OPENING SIZES REQUIRED BY DIFFERENT WINDOW AND DOOR MANUFACTURERS. THE CONTRACTOR IS URGED TO VERIFY THE OPENINGS REQUIRED BY THE MANUFACTURER SELECTED (BY THE CONTRACTOR OR BY THE OWNER) FOR THIS PROJECT.
- THE CONTRACTOR SHALL CONFIRM THE REQUIREMENTS AS TO SIZE, SHAPE AND ANCHORING OF WOOD BUCKS FOR DOORS AND WINDOWS WITH THE SELECTED MANUFACTURER TO PROVIDE THE MOST EXACT AND BEST FITTING OPENING.
- THE CONTRACTOR IS RESPONSIBLE TO COORDINATE THE **EXACT DIMENSION OF THE MASONRY OPENINGS WITH THE** WINDOW AND DOOR ASSEMBLIES, IN ANY AND ALL CASES. THE CONTRACTOR SHALL NOT DEPEND ON THE INFORMATION GIVEN IN THESE PLANS AND SCHEDULES FOR THE PURPOSE OF COORDINATING THIS WORK FOR CONSTRUCTION. THE MEANS AND METHODS OF CONSTRUCTION ARE, AND SHALL REMAIN, THE CONTRACTOR'S RESPONSIBILITY.
- 7. IN THE EVENT OF A CHANGE IN DOOR OR WINDOW MANUFACTURER(S), WHETHER SELECTED BY THE OWNER OR THE CONTRACTOR, THE PLANS AND SCHEDULES SHOULD BE REVISED SO THAT THE PERMIT SET REFLECTS THE CHANGE AND, THEN AFTER CONSTRUCTION, SO THAT THE (FINAL) RECORD DRAWINGS REFLECTS THE ACTUAL, AS-BUILT CONDITION.

KEY NOTES

- 1/2" GYPSUM BOARD OVER 1" X 2" P.T. WOOD FURRING STRIPS AT 24" O.C. WITH R-5 INSULATION. TYPICAL ON NEW PERIMETER CONCRETE BLOCK WALLS UNLESS OTHERWISE NOTED.
- 1/2" GYPSUM BOARD OVER 1" X 2" P.T. WOOD FURRING STRIPS AT 16" O.C. WITH R-5 INSUL. ON EXIST. CONCRETE BLOCK WALL
- 1/2" GYPSUM BOARD OVER 1- 1/8" X 3-1/8" METAL STUDS AT 24" O.C TYPICAL FOR INTERIOR PARTITIONS UNLESS OTHERWISE NOTED
- _CERAMIC TILE OVER 1/2" CEMENTITIOUS BOARD ON WET SIDE OF WALL UNLESS OTHERWISE NOTED.
- CEILING: 1/2" GYPSUM BOARD OVER 1"X3" METAL HI-HATS AT 16" O.C. TYPICAL UNLESS OTHERWISE NOTED.
- CEILING: NEW 2" TONGUE AND GROOVE CEILING
- 3 COAT (5/8" MIN. THICKNESS) STUCCO FINISH ON CONCRETE BLOCK WALL -TEXTURE TO MATCH EXISTING-

WALL TYPES NOTES:

- 1.- PARTITION TYPE DESCRIPTIONS AREA NOT TO BE CONSTRUED AS COMPLETE ASSEMBLY INSTRUCTIONS. CONTRACTOR IS TO CONSTRUCT PARTITIONS ACCORDING TO THE COMPLETE ASSEMBLY REQUIREMENTS LISTED IN THE REFERENCED TESTING LABORATORY MANUALS. ADDITIONAL ITEMS SHOWN SHALL BE PROVIDED.
- 2. PARTITION TAGS = ARE TYPICALLY FOUND ON THE 1/4" SCALE FLOOR PLANS. DROPPED CEILINGS: FOR LOCATIONS SEE REFLECTIVE CEILING & FLOOR PLANS. ROOM FINISH SCHEDULE: SEE FLOOR PLANS
- 3.- TYPICAL INTERIOR METAL STUDS U.O.N. 4" AND 6" = STUD SIZE 16" O.C. MAX. = STUD FRAME SPACING
- 4.- FRAME AND BRACE AS REQUIRED AROUND ALL PIPING AND DUCTWORK TO MAINTAIN PARTITION SUPPORT.
- 5.- PROVIDE MINIMUM 1" RIGID INSULATION (R VALUE=5) ON ALL EXTERIOR BLOCK WALL APPLICATIONS THAT HAVE AN ADJACENT AIR CONDITIONED SPACE UP TO BOTTOM OF
- 6. PROVIDE CONCEALED BLOCKING IN STUD FRAMED PARTITIONS, FURRED & CHASED WALLS AS REQUIRED BY THE ACCESSORY BEING MOUNTED, IE: LAV. COUNTERS, O/H KITCHEN CABINETS, SHOWER CURTAIN & CLOSET RODS, GRAB BARS, HANDRAILS,
- .- PROVIDE ACOUSTICAL SEALANT AROUND THE PERIMETER (TOP-BOTTOM-ENDS) OF ALL PARTITIONS. SEALANT SHALL BE
- 8. GYPSUM BOARD WALLS AND CEILING IN "WET" AREAS (IE: RESTROOMS) SHALL BE MOISTURE-RESISTANT TYPE.
- 9.- PROVIDE 1/2" DUROCK AROUND PERIMETER OF SHOWER AND TUB AREAS (TYP.)

EXISTING CBS WALL TO REMAIN

NEW CBS WALL

NEW PARTITION WALL

NEW CONCRETE SLAB

SCONCE (EXTERIOR)

SCONCE (INTERIOR)

TV OUTLET

EXTRACTION VENT

TELEPHONE OUTLET

CEILING MOUNTED LIGHT

CHANDELIER

A/C DIFFUSERS

FLOOD LIGHTS

CEILING FAN

SWITCH (WITH DIMMER)

DUPLEX RECEPTACLE OUTLET

SPOT LIGHTS (CEILING MOUNTED)

COFFERED CEILING ELEV. 9'-4"

2" TONGUE AND GROOVE CEILING

EXISTING CBS WALL TO BE REMOVED

EXISTING PARTITION WALL TO REMAIN

EXISTING PARTITION WALL TO BE REMOVED

EXISTING CONCRETE SLAB TO BE REMOVED

SMOKE/ CARBON MONOXIDE DETECTOR

4' LONG FLORESCENT LIGHT WITH LENS

JUNCTION BOX FOR UNDERCABINET LIGHTS

LEGEND:

TYPE: 13 ZONE: 5

PRESS: +54.24 PSF

SUCT: -70.94 PSF

NEW ROOF STRUCTURE. SEE

MATERIALS AND SPECIFICATIONS

ARCHITECTURAL DRAWINGS FOR ROOF-

APPLY TINTED PRIMER/ SEALER AND 2

COAT PAINT. PAINT AS SELECTED BY

3 COAT (5/8" MIN. THICKNESS)

STUCCO FINISH ON CONCRETE-

NEW TRELLIS. SEE STRUCTURAL

DRAWINGS FOR SPECIFICATIONS

NEW ROOF STRUCTURE. SEE

+10'-0" TIE BEAM ELEVATION

+7'-2" TRELLIS BEAM ELEV.

3 COAT (5/8" MIN. THICKNESS)

F. FLOOR ELEVATION

F.F.E. @ POOL DECK

APPLY TINTED PRIMER/ SEALER AND 2

COAT PAINT. PAINT AS SELECTED BY

COATS MIN. LATEX ACRYLIC FINISH TOP

MATERIALS AND SPECIFICATIONS

ARCHITECTURAL DRAWINGS FOR ROOF-


F. FLOOR ELEVATION

F.F.E. @ POOL DECK

COATS MIN. LATEX ACRYLIC FINISH TOP

ALL FINISHES AS SELECTED BY OWNER

CATHEDRAL CEILING

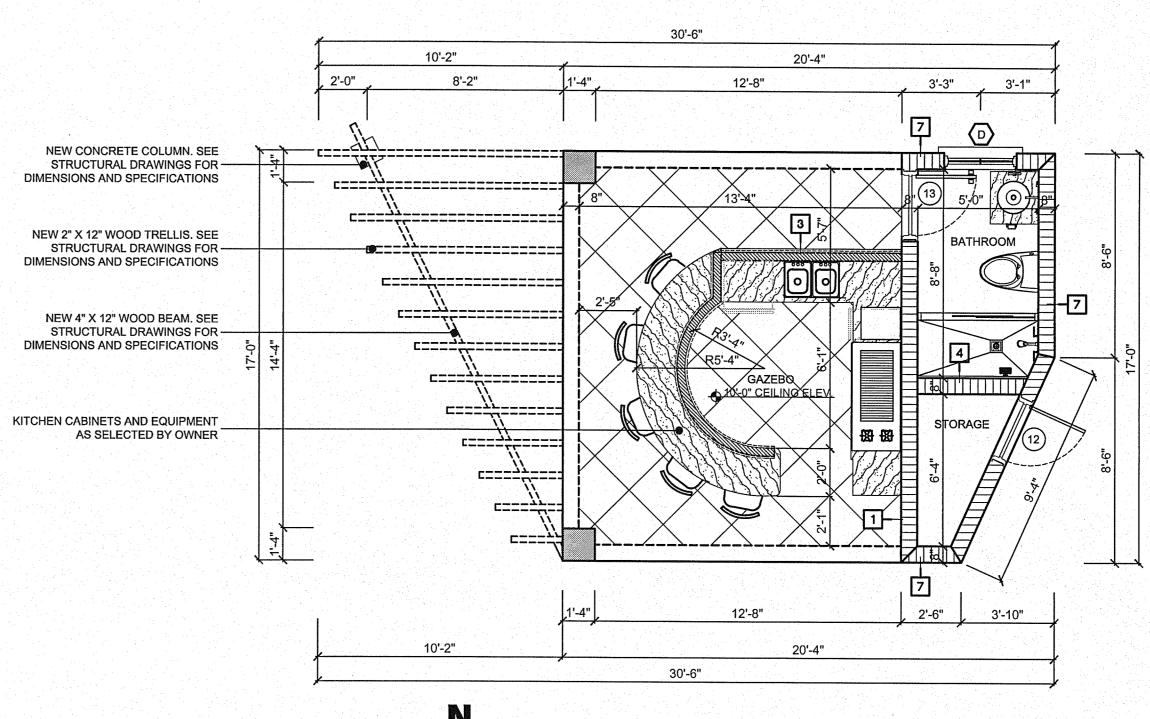



NEW ROOF STRUCTURE. SEE

MATERIALS AND SPECIFICATIONS

DRAWINGS FOR SPECIFICATIONS

STUCCO FINISH ON CONCRETE

APPLY TINTED PRIMER/ SEALER AND 2

COAT PAINT. PAINT AS SELECTED BY

COATS MIN. LATEX ACRYLIC FINISH TOP

BLOCK WALL

F. FLOOR ELEVATION

SPECIFICATIONS

F.F.E. @ POOL DECK

ARCHITECTURAL DRAWINGS FOR ROOF

GAZEBO FLOOR PLAN

P.E. 61836 15263 SW 35th TERRACE Miami, Florida 33185 (786) 514-2584

PROJECT:

DESIGN TEAM:

JULIO PULIDO, AIA

ARCHITECTURE - PLANNING

12721 S.W. 30 ST. MIAMI, FL 33175

PH: (305) 505-6910 - AR93904

MIAMI ENGINEERING SERVICES

PHONE: 305 556 2542

665 WEST 20 AVE, # 315 HIALEAH, FL 33012

nes@miamiesinc.com http://www.miamiesinc.cor

JORGE LUIS FLEITAS

P.E. 55340

16500 N.W. 91st ct.

Miami Lakes, Florida 33018

Cel: 305-401-4395

AIDA SARDINAS, P.E.

OWNER: EDUARDO DUQUE YUDELKIS ESPINOSA **11245 SW 58 TERRACE** MIAMI, FL 33156

PROJECT: ADDITION. **RENOVATION AND REMODELING TO: CANAL RESIDENCE 11245 SW 58 TERRACE MIAMI, FL 33156**

DATE

MARCH 04, 2011

042-11


L.P.

J.P.

TYPE: 12 ZONE: 4 PRESS: +54.24 PSF SUCT: -70.94 PSF

PROPOSED EAST ELEVATION


STORAGE S CEILING @ 10'-0"

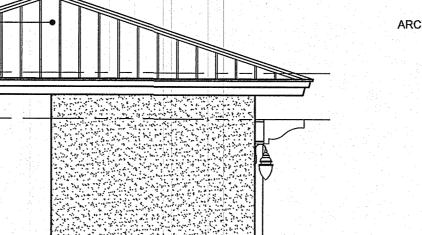

SCALE: 1/4"=1'-0'

NEW ROOF STRUCTURE. SEE ARCHITECTURAL DRAWINGS FOR ROOF-MATERIALS AND SPECIFICATIONS +7'-2" TRELLIS BEAM ELEV. NEW CASEMENT WINDOW . SEE WINDOW SCHEDULE FOR-3 COAT (5/8" MIN. THICKNESS) STUCCO FINISH ON CONCRETE APPLY TINTED PRIMER/ SEALER AND 2 COATS MIN. LATEX ACRYLIC FINISH TOP COAT PAINT. PAINT AS SELECTED BY F. FLOOR ELEVATION F.F.E. @ POOL DECK

PROPOSED NORTH ELEVATION SCALE: 1/4"=1'-0"

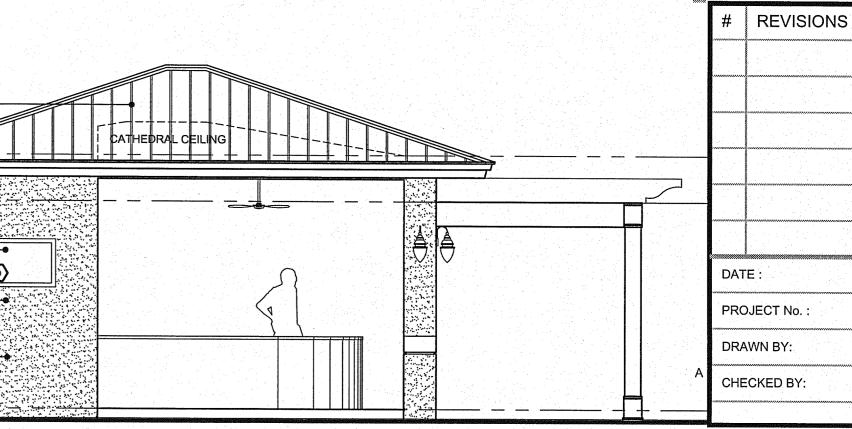

SCALE: 1/4"=1'-0"

SHEET TITLE:

MANAGEMENT

GAZEBO PLANS AND ELEVATIONS

SHEET No:

PROPOSED WEST ELEVATION SCALE: 1/4"=1'-0"

TYPE: 12 ZONE: 4

PRESS: +54.24 PSF

SUCT: -70.94 PSF

PROPOSED SOUTH ELEVATION

TYPE: D ZONE: 5

PRESS: +56.8 PSF

Miami Dade County Building Department 0000824936 - 5/10/2011 7:24:04 AM

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Disp. Trade Stamp Name Date Time Stamp Francisco Borges 5/4/2011 7:55:21 AM A PLUM Approved

NOTE: (F.B.C. 109.3.6.4.4) "TO THE BEST OF THE ARCHITECT'S KNOWLEDGE, THE PLANS AND SPECIFICATIONS COMPLY WITH THE APPLICABLE MINIMUM BUILDING CODES AND THE APPLICABLE FIRE-SAFETY STANDARDS AS DETERMINED BY THE LOCAL AUTHORITY IN ACCORDANCE WITH THIS SECTION AND CHAPTER 633 OF THE FLORIDA STATUES."